




ISO A1 594mm x 841mm

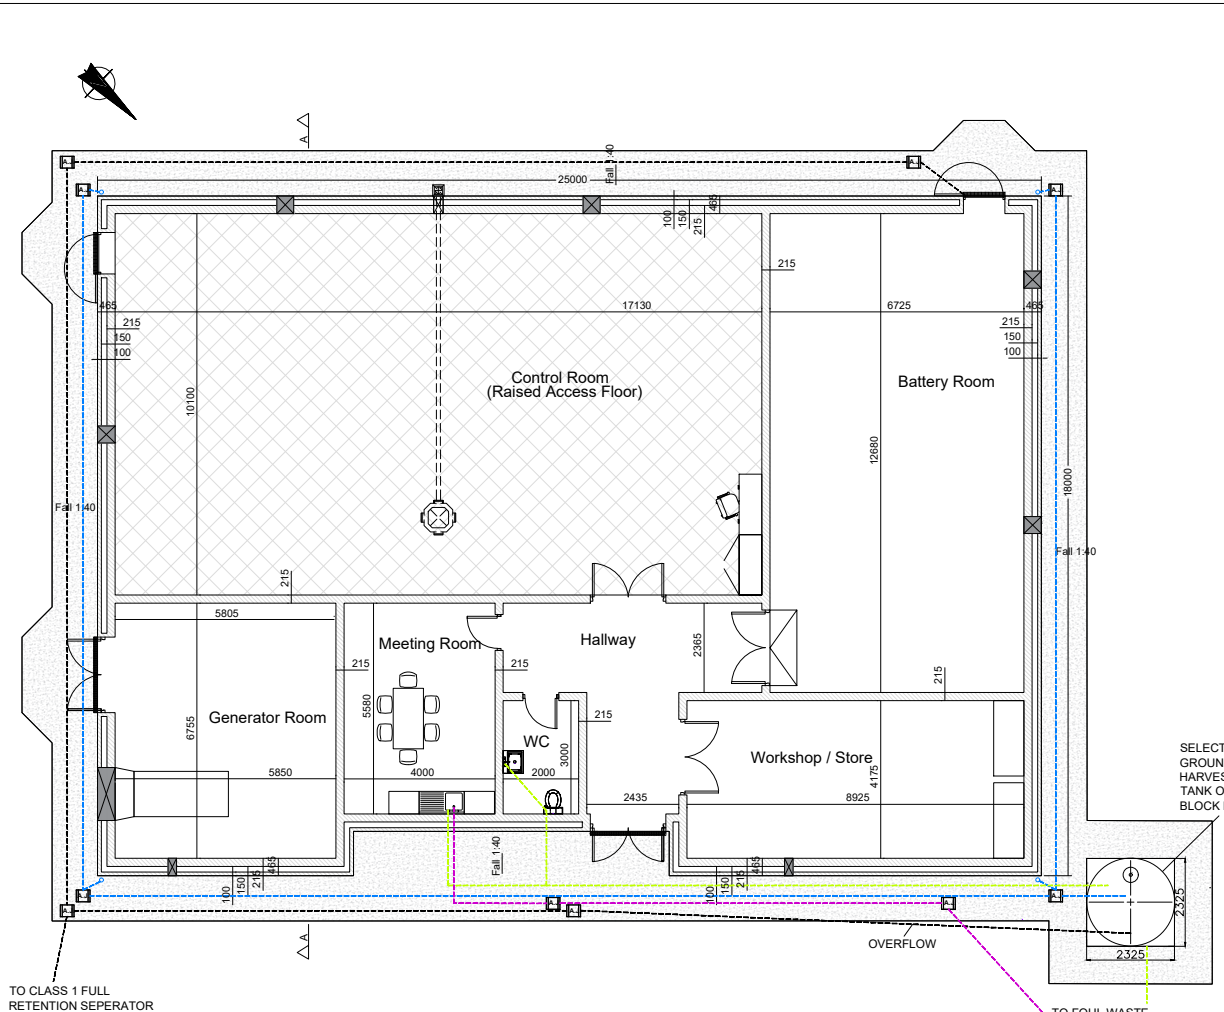


**PLAN - CONTROL BUILDING**  
Scale : 1:100

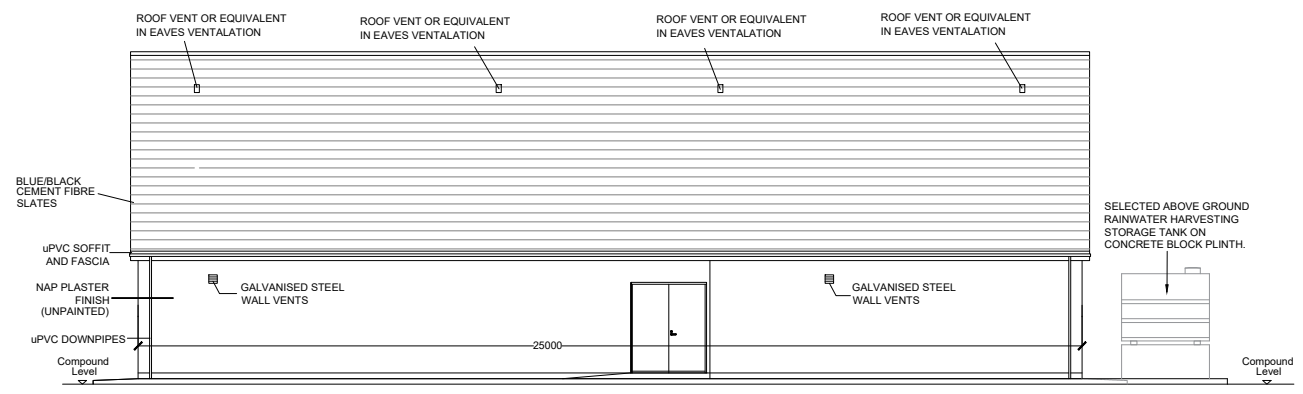


**NORTH EAST ELEVATION**  
Scale : 1:100

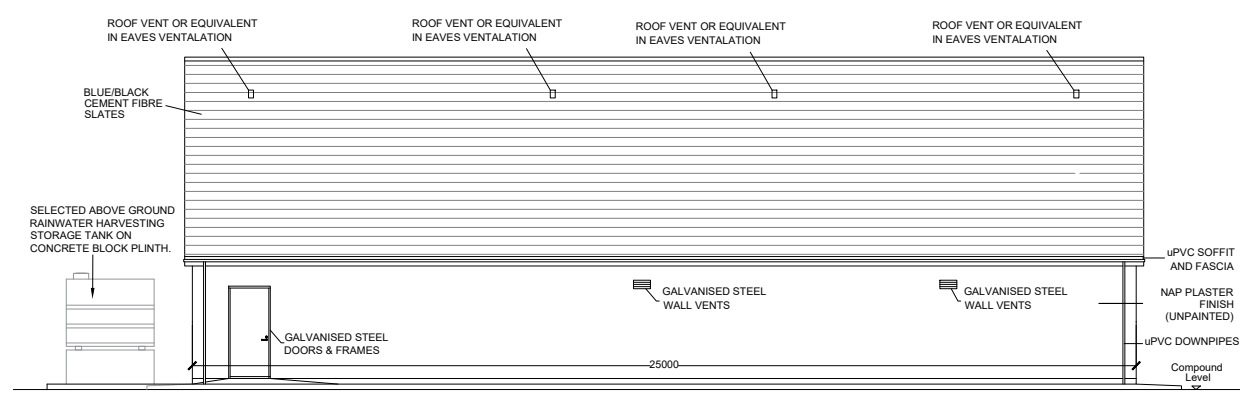

**SOUTH WEST ELEVATION**  
Scale : 1:100

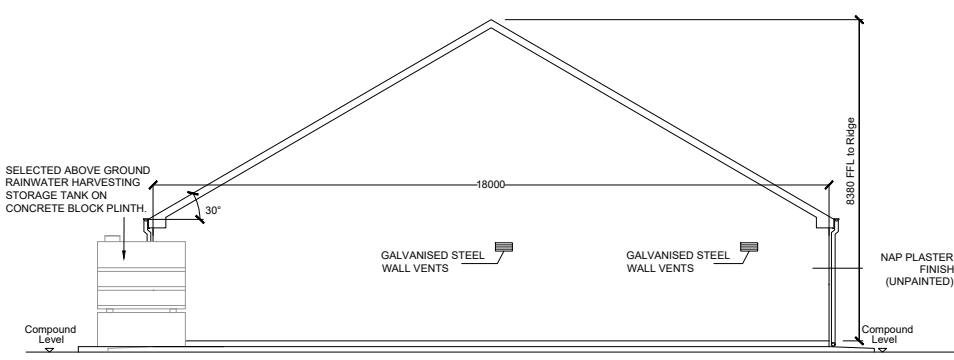


**NORTH WEST ELEVATION**  
Scale : 1:100

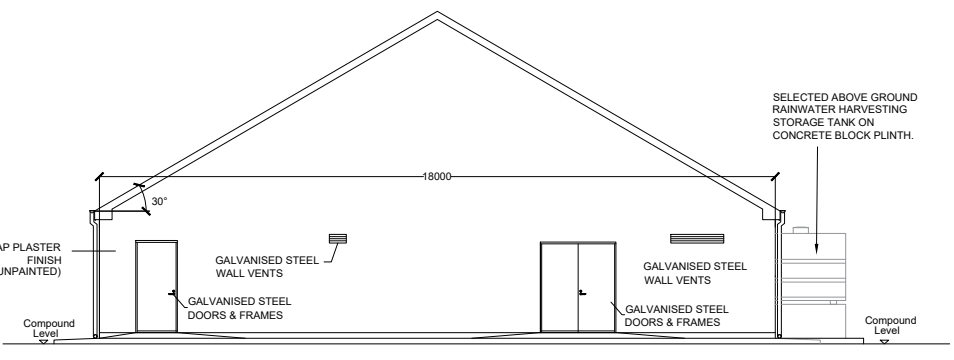

**SOUTH EAST ELEVATION**  
Scale : 1:100

**CAVITY WALL:**  
FLAT SAND / CEMENT PLASTER FINISH TO 100MM OUTER LEAF, 100MM CAVITY, 215MM INNER LEAF, INSIDE FACE OF INNER LEAF TO REMAIN FAIR-FACED. CAVITY WALL SUPPORTED ON CONCRETE STRIP FOUNDATION.

**ROOF CONSTRUCTION:**  
ROOF SLATE ON TREATED SW ROOF BATTENS ON SELECTED BREATHER MEMBRANE ON SELECTED SW PREFABRICATED ROOF TRUSS SYSTEM FIXED TO TREATED 100X75MM SW WALLPLATE. INTERNAL CEILING TO BE 200MM HOLLOWCORE SLAB FOR SECURITY PURPOSES.

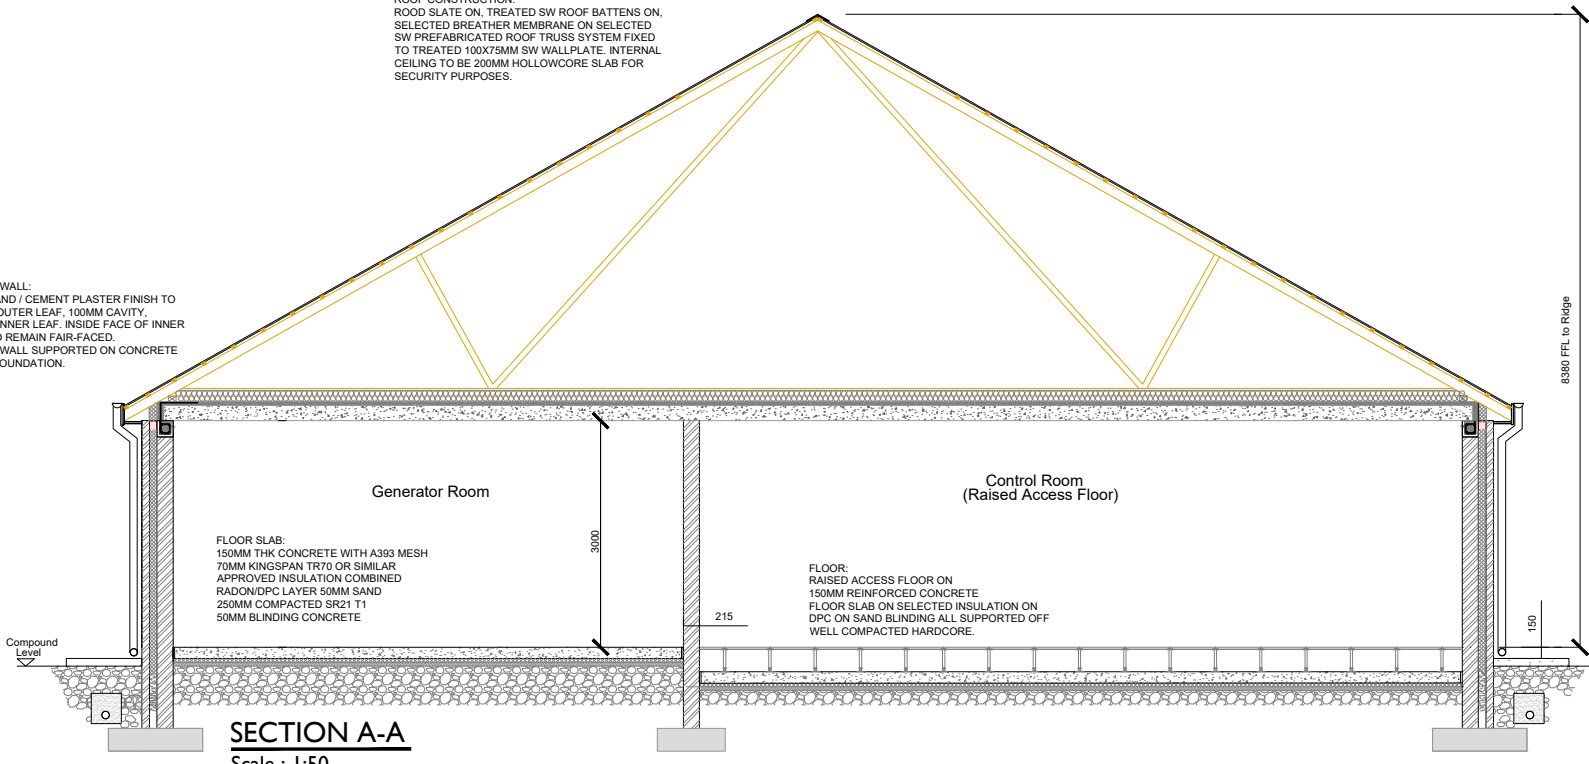

**SECTION A-A**  
Scale : 1:50



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**PROJECT**  
**Dyrick Hill Wind Farm**

**CLIENT**

**CONSULTANTS**

- NOTES:-**
- Layout and Arrangements of Substation Building and Electrical Equipment is shown indicatively and for illustration purposes only.
  - Dimensions shown are as per current EirGrid Specifications at the time of submission. Dimensions may vary at time of construction to reflect any revisions to EirGrid Specifications.
  - Final Specifications of Buildings and Electrical Equipment is to be as per Eirgrid and ESB Specifications.
  - The Elevation of the Compound will be depicted by localized Topography such that Cut/Fill Earthworks associated with the construction of the Compound are balanced.

- LEGEND:-**
- Levels shown thus -779.10m
  - Concrete Footpath shown thus
  - Foul Sewer shown thus
  - Clean Storm Water shown thus
  - Dirty Storm Water shown thus
  - Water supply from Harvesting Tank shown thus

**ISSUE/REVISION**

NO	DATE	DESCRIPTION
P0	16.09.22	Issued for Information
I/R	DATE	DESCRIPTION

**PROJECT NUMBER**  
05-829

**SHEET TITLE**  
Control Building - Plan & Elevations & Section

**SHEET NUMBER**  
05829-DR-181

Project Management Initials: Designer: AF Checked: DB Approved: RG